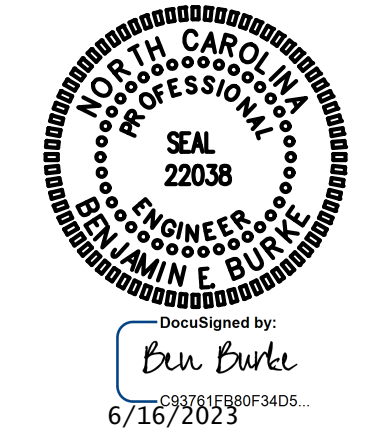


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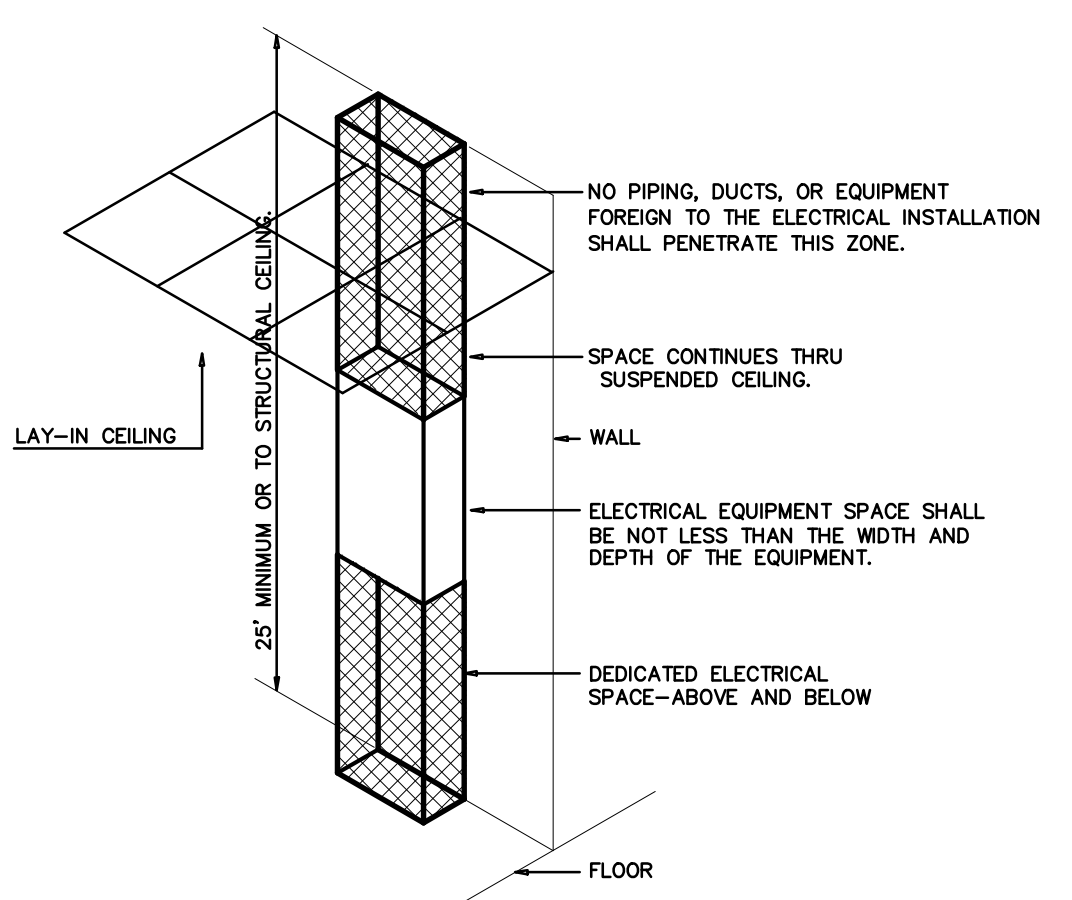


### GENERAL NOTES

- ALL ELECTRICAL WORK SHALL BE IN ACCORDANCE WITH THE NATIONAL ELECTRICAL CODE AND ALL LOCAL CODES HAVING JURISDICTION.
- ALL BRANCH CIRCUIT CONDUCTORS TO BE COPPER. SERVICE CONDUCTORS TO BE COPPER UNLESS OTHERWISE SPECIFIED. ALUMINUM CONDUCTORS ARE NOT ALLOWED.
- ALL CIRCUITS TO BE 2 #12, 1 #12 GND IN 1/2" EMT CONDUIT AS A MINIMUM. PROVIDE WIRING FOR LARGER CIRCUITS AS REQUIRED BY NEC. RIGID CONDUIT IS REQUIRED WHERE EXPOSED BELOW 8'-0" A.F.F.
- ALL EMPTY CONDUIT RUNS IN EXCESS OF 10 FEET SHALL BE PROVIDED WITH A PULL WIRE OR FISH TAPE/CORD.
- CONTRACTOR SHALL VERIFY THAT ALL DOOR SWINGS ARE CORRECT BEFORE INSTALLING LIGHT SWITCH OUTLETS.
- ALL BRANCH CIRCUIT CONDUCTORS FROM THE PANEL TO THE FIRST OUTLET SHALL BE INCREASED TO THE NEXT LARGER SIZE WHERE THE LENGTH OF THE HOME RUN EXCEEDS 120 FEET ON 120V AND 208V CIRCUITS.
- THE CORRECT NUMBER OF WIRES MAY NOT BE INDICATED FOR ALL CIRCUITS, ONLY THOSE WHERE CLARIFICATION IS NECESSARY. THE ELECTRICAL CONTRACTOR SHALL PROVIDE ALL WIRES NECESSARY FOR THE PROPER FUNCTION OF THE SYSTEM WHETHER INDICATED ON DRAWINGS OR NOT.
- THE CONTRACTOR SHALL BE RESPONSIBLE FOR CORRECTLY PHASING THE CIRCUITS IN THE PANELBOARDS.
- SCHEDULE ELECTRICAL INSPECTIONS WITH THE STATE ELECTRICAL INSPECTOR FOR MONDAY THROUGH FRIDAY
- ELECTRICAL REQUIREMENTS INDICATED ON DRAWINGS MAY DIFFER FROM ACTUAL EQUIPMENT FURNISHED. IF FURNISHED EQUIPMENT DIFFERS FROM RATINGS ON DRAWINGS CONTRACTOR SHALL NOTIFY ARCHITECT/ENGINEER FOR APPROPRIATE ACTION TO BE TAKEN.
- IT SHALL BE THE RESPONSIBILITY OF THE ELECTRICAL CONTRACTOR TO COORDINATE EXACT BREAKER REQUIREMENTS FOR ALL EQUIPMENT PRIOR TO ORDERING PANEL. ADJUST BREAKER AND WIRE SIZES AS REQUIRED.
- PROVIDE BOXES, JACKS, WIRING AND CONDUIT FROM LOCATIONS SHOWN TO MTP LOCATION. VERIFY EXACT REQUIREMENTS WITH OWNER.
- ELECTRICAL CONTRACTOR SHALL PROVIDE ALL DISCONNECTS FOR MECHANICAL & PLUMBING EQUIPMENT. DISCONNECTS SHALL BE PER MANUFACTURERS RECOMMENDATIONS AND FUSED PER NAME PLATE. PROVIDE NEMA 3R ENCLOSURES ON EXTERIOR. COORDINATE FUSE SIZES.
- OMIT --


### ELECTRICAL LEGEND

- LIGHT FIXTURE: LETTER DENOTES FIXTURE TYPE (REFER TO LIGHTING PLAN AND FIXTURE SCHEDULE). NL = NIGHT LIGHT (NOT SWITCHED/ALWAYS ON)
- DUPLEX RECEPTACLE - 120V; MOUNT 18" TO CENTER AFF UNLESS NOTED OTHERWISE; "WP" INDICATES WEATHER PROOF; PROVIDE IN-USE COVER. "GFI" INDICATES GROUND FAULT CURRENT INTERRUPT PROTECTED. "U" INDICATES RECEPTACLE WITH (2) USB PORTS.
- QUADRUPLEX RECEPTACLE - 120V
- FLOOR OR CEILING OUTLET (AS NOTED) - 120V
- SPECIAL PURPOSE RECEPTACLE - REFER TO POWER PLAN AND PANEL SCHEDULE
- LIGHT SWITCH
- SWITCH WITH INTEGRAL PIR/US MOTION SENSOR FOR AUTOMATIC SHUT-OFF WITH UP TO 2 HOUR ADJUSTABLE DELAY.
- DIMMABLE LIGHT SWITCH
- MOTOR RATED SWITCH
- JUNCTION BOX
- TELE/DATA OUTLET - PROVIDE JUNCTION BOX WITH CONDUIT BACK TO MTP, PROVIDE (1) TELEPHONE JACK AND (1) CAT 5 DATA JACK
- SINGLE-POLE HOMERUN TO PANELBOARD
- TWO-POLE OR 3-POLE HOMERUN TO PANELBOARD
- EXIT LIGHT
- EMERGENCY EGRESS FIXTURE
- PHOTOCCELL (LED COMPLIANT)
- BRANCH CIRCUIT WIRING
- SWITCH LEG
- GROUND CONNECTION
- DISTRIBUTION PANELBOARD
- DISCONNECTING MEANS AS REQUIRED BY CODE



ELECTRICAL EQUIPMENT DEDICATED SPACE PER ARTICLE 110.26.F.1 OF N.E.C.

1 DEDICATED SPACE  
 SCALE: NTS

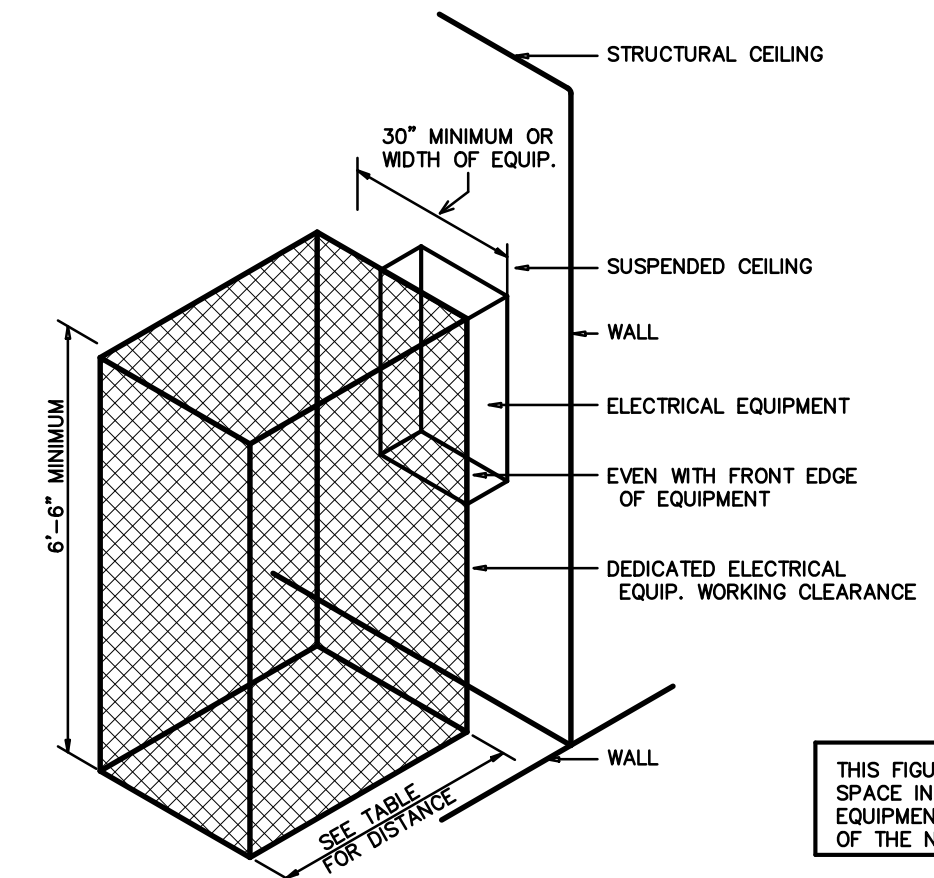

ELECTRICAL EQUIPMENT WORKING CLEARANCE PER ARTICLE 110-26 OF N.E.C.

VOLTAGE TO GROUND NOMINAL	WORKING CLEARANCES			
	MIN. CLEAR DISTANCE IN FEET	1	2	3
0-150	3	3	3	3
151-600	3	3-1/2	4	

THIS FIGURE ILLUSTRATES THE WORKING SPACE IN FRONT OF THE ELECTRICAL EQUIPMENT REQUIRED BY SECTION 110-16 OF THE N.E.C.

- WHERE THE CONDITIONS ARE AS FOLLOWS:
- EXPOSED LIVE PARTS ON ONE SIDE AND NO LIVE OR GROUNDED PARTS ON THE OTHER SIDE OF THE WORKING SPACE, OR EXPOSED LIVE PARTS ON BOTH SIDES EFFECTIVELY GUARDED BY SUITABLE WOOD OR INSULATED BUSBARS OPERATING AT NOT OVER 300V SHALL NOT BE CONSIDERED LIVE PARTS.
  - EXPOSED LIVE PARTS ON ONE SIDE AND GROUNDED PARTS ON THE OTHER SIDE.
  - EXPOSED LIVE PARTS ON BOTH SIDES OF THE WORK SPACE (NOT GUARDED AS PROVIDED IN CONDITION 1) WITH THE OPERATOR BETWEEN.

2 ELECTRICAL CLEARANCES  
 SCALE: NTS

2018 APPENDIX B  
 BUILDING CODE SUMMARY FOR ALL COMMERCIAL PROJECTS  
 ELECTRICAL DESIGN  
 (PROVIDE ON THE ELECTRICAL SHEETS IF APPLICABLE)

ELECTRICAL SUMMARY

ELECTRICAL SYSTEM AND EQUIPMENT

Method of Compliance: ENERGY CODE-PRESCRIPTIVE

Lighting schedule (each fixture type)

- lamp type required in fixture
- number of lamps in fixture
- ballast type used in the fixture
- number of ballasts in fixture
- total wattage per fixture
- total interior wattage specified vs. allowed 1015VA / 1109VA
- total exterior wattage specified vs. allowed 973VA / 1060VA

Additional Efficiency Package Options  
 (When using the 2018 NCECC; not required for ASHRAE 90.1)

- C406.2 More Efficient HVAC Equipment Performance
- C406.3 Reduced Lighting Power Density
- C406.4 Enhanced Digital Lighting Controls
- C406.5 On-Site Renewable Energy
- C406.6 Dedicated Outdoor Air System
- C406.7 Reduced Energy Use in Service Water Heating


BID SET 4.28.22  
 WVS: 15RE.13.3  
 SCO ID# 21-24079-01A

PROJECT TITLE  
 BRUNSWICK CTY  
 VISITOR'S CENTER  
 394 WHITEVILLE ROAD NW  
 SHALLOTE, NORTH CAROLINA

PROJECT NO.  
 2104A  
 DRAWING TITLE  
 ELEC. SPECS & DETAILS

PLOT DATE 6/16/23

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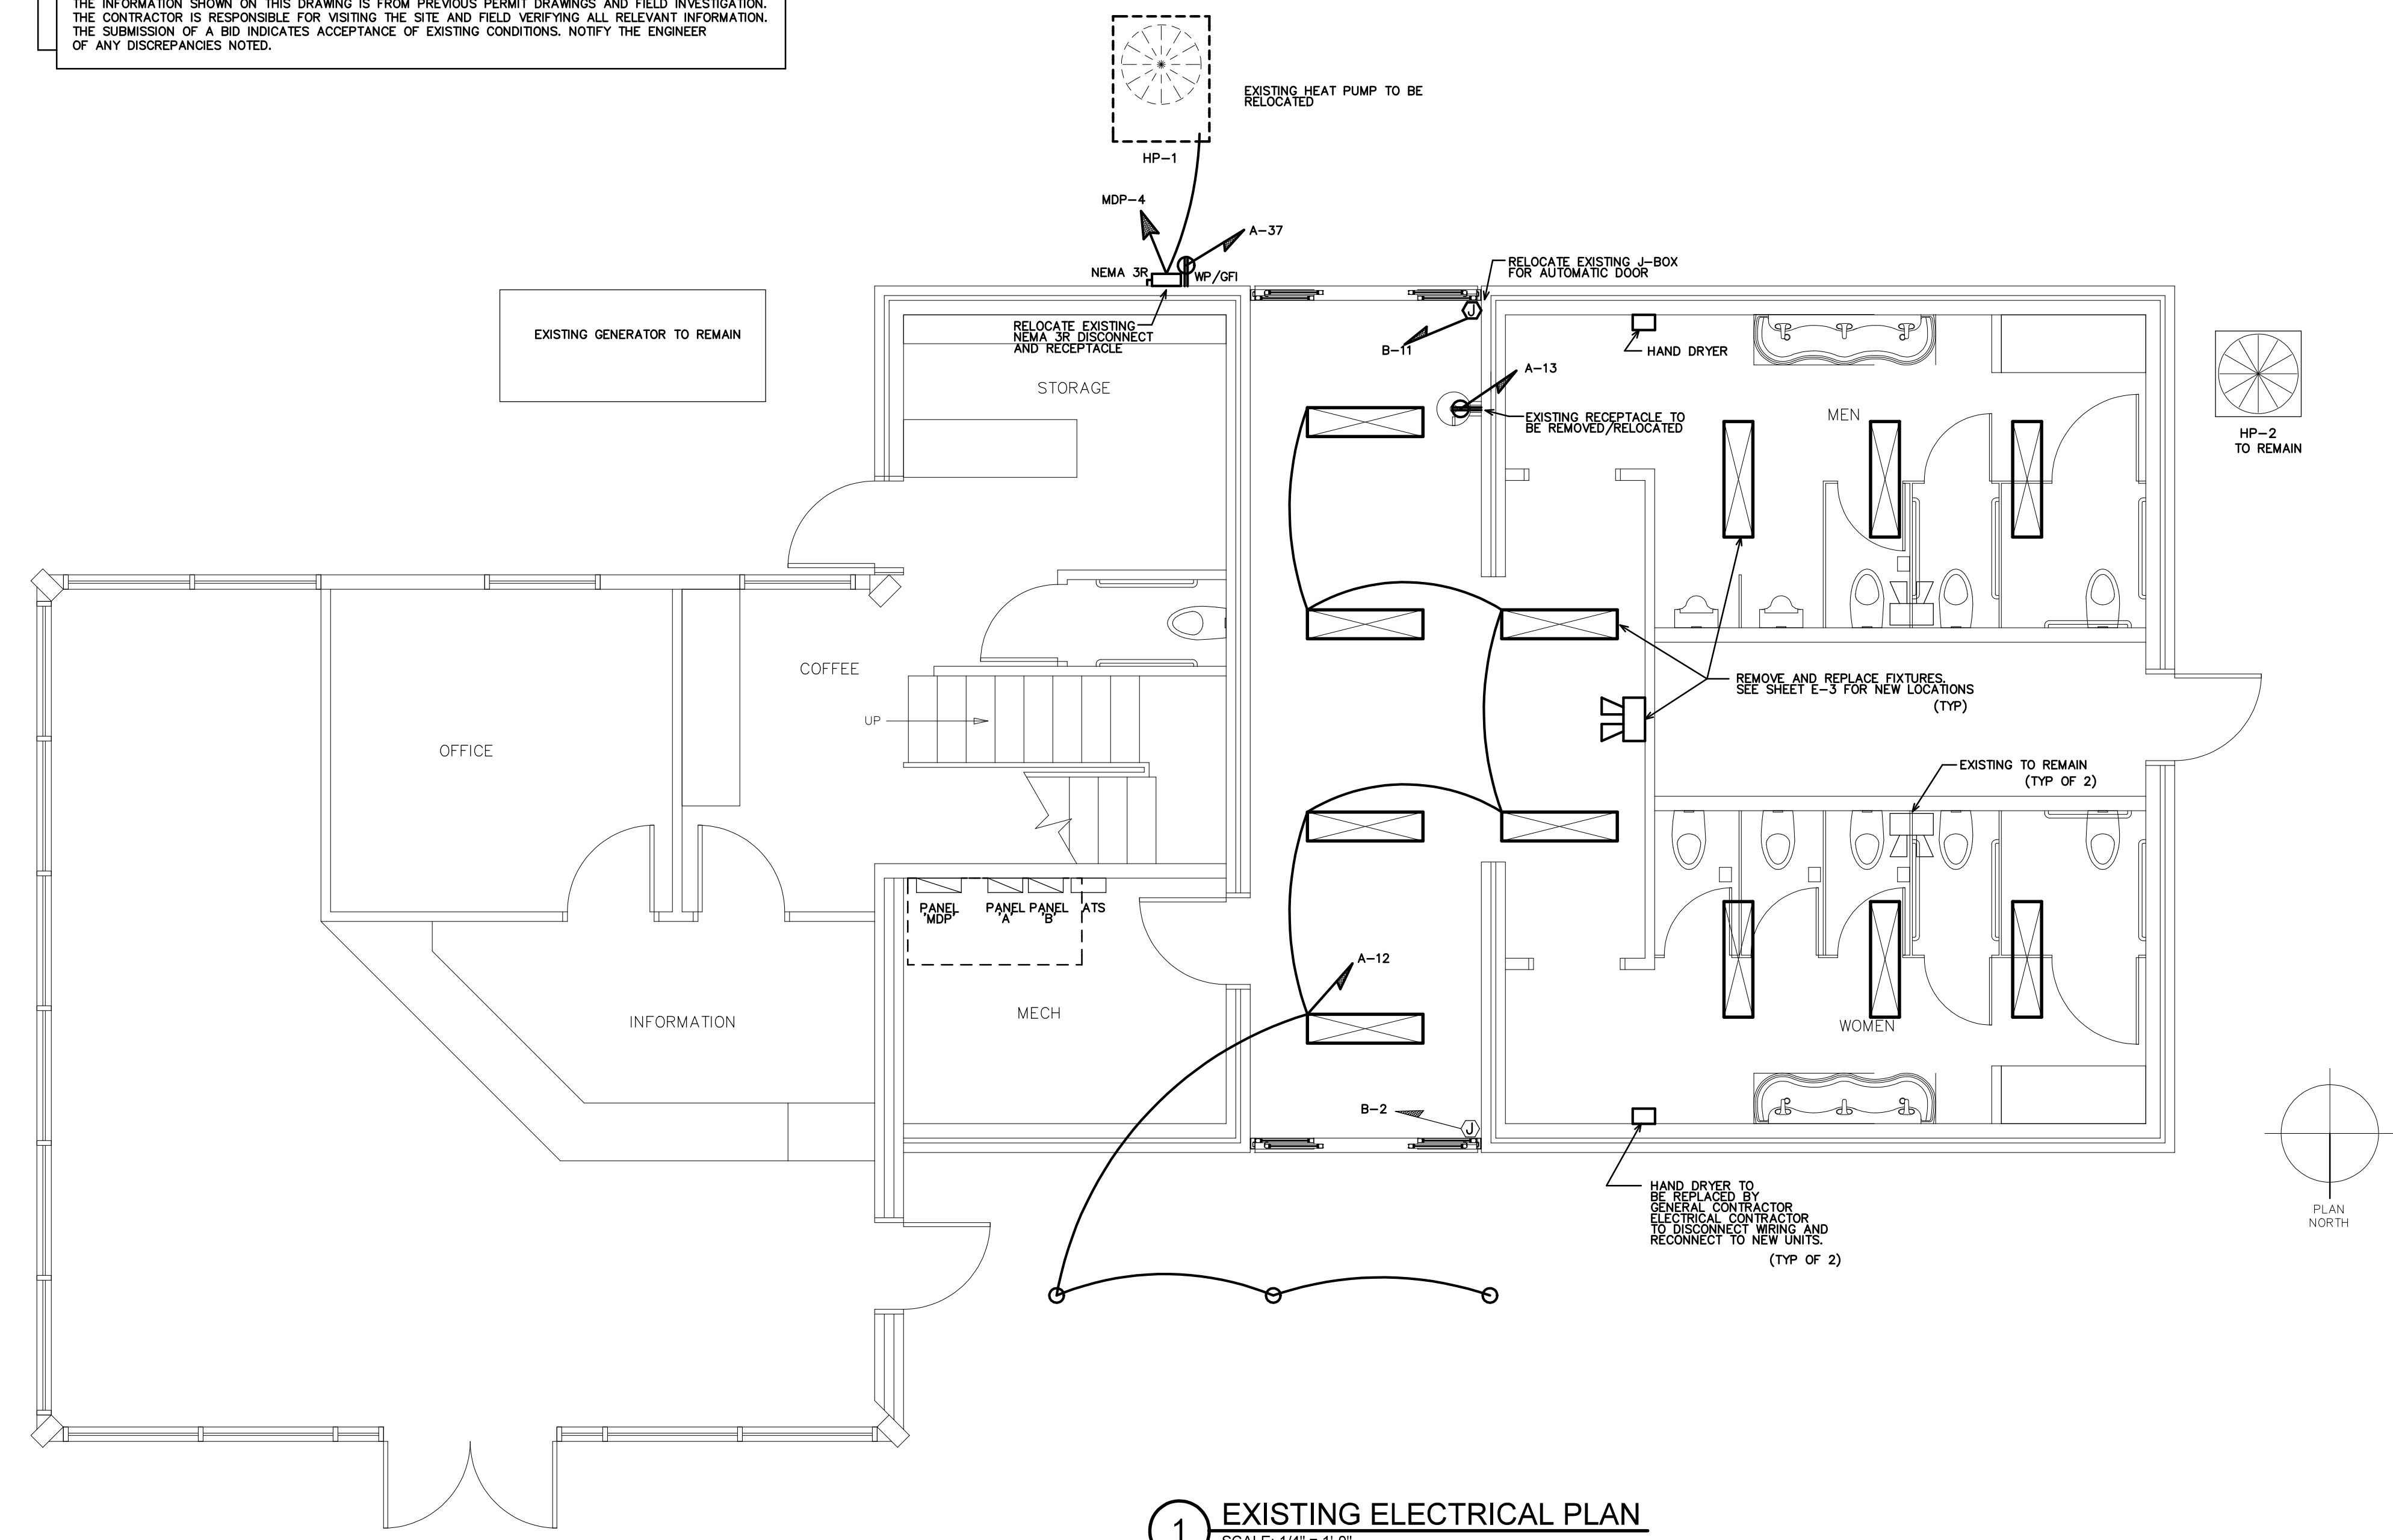
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ENGINEER

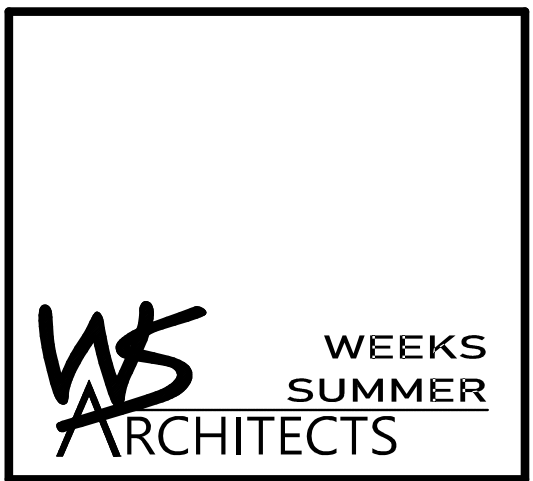
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NOTE:  
THE INFORMATION SHOWN ON THIS DRAWING IS FROM PREVIOUS PERMIT DRAWINGS AND FIELD INVESTIGATION.  
THE CONTRACTOR IS RESPONSIBLE FOR VISITING THE SITE AND FIELD VERIFYING ALL RELEVANT INFORMATION.  
THE SUBMISSION OF A BID INDICATES ACCEPTANCE OF EXISTING CONDITIONS. NOTIFY THE ENGINEER  
OF ANY DISCREPANCIES NOTED.




**1 EXISTING ELECTRICAL PLAN**  
SCALE: 1/4" = 1'-0"



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WVS: 15RE.13.3  
SCO ID# 21-24079-01A

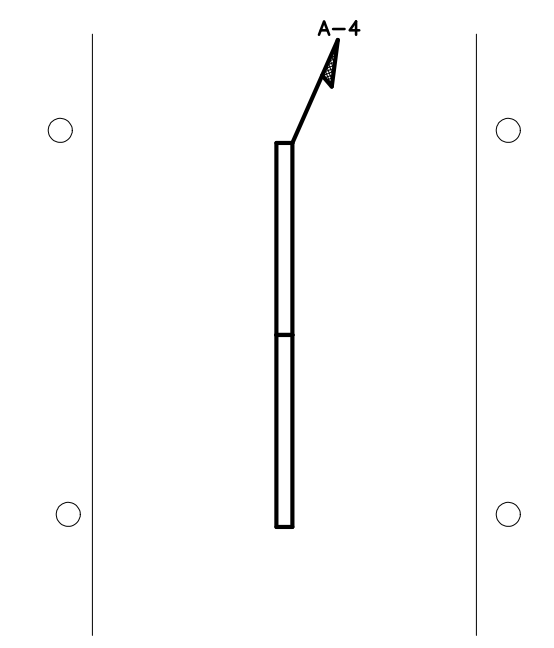PROJECT TITLE  
**BRUNSWICK CTY  
VISITOR'S CENTER**  
394 WHITEVILLE ROAD NW  
SHALLOTE, NORTH CAROLINA


PROJECT NO.  
**2104A**  
DRAWING TITLE  
**EXISTING ELEC PLAN**

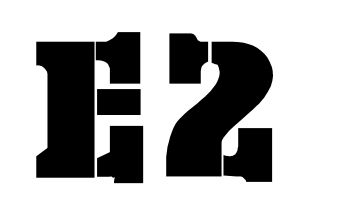


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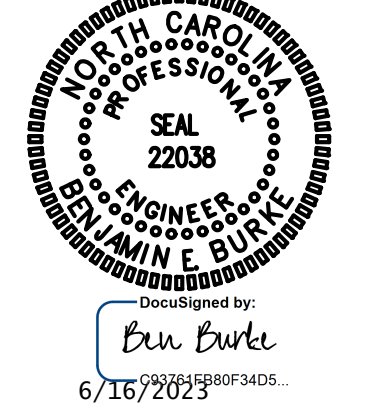
PARTIAL LIGHTING SCHEDULE - SEE E4	
MARK	REMARKS
A1	4' LED SURFACE MOUNT LINEAR FIXTURE
A2	4' LED PENDANT MOUNT INDIRECT/DIRECT LINEAR FIXTURE
AW	4' LED SURFACE MOUNT LINEAR WALL WASH FIXTURE
B1	EXTERIOR 4" RECESSED LED CAN FIXTURE, (EM) INDICATES EMERGENCY BATTERY PACK OPTION
B2	EXTERIOR LED SURFACE MOUNT LIGHT FIXTURE
C	6" LED RECESSED CAN FIXTURE
D	WEATHERPROOF LED LINEAR FIXTURE
F2	2' LED WALL MOUNT DIRECT/INDIRECT FIXTURE
F4	4' LED WALL MOUNT DIRECT/INDIRECT FIXTURE
F8	8' LED WALL MOUNT DIRECT/INDIRECT FIXTURE
F12	12' LED WALL MOUNT DIRECT/INDIRECT FIXTURE
EWI	EMERGENCY LIGHTING INVERTER, 110W CAPACITY
ESL	LED EXIT SIGN, COLOR BY ARCH
ELB	EMERGENCY LIGHT, BATTERY BACKUP, BATTERY DIAGNOSTICS, COLOR BY ARCH



1 REVISED ELECTRICAL PLAN  
SCALE: 1/4" = 1'-0"
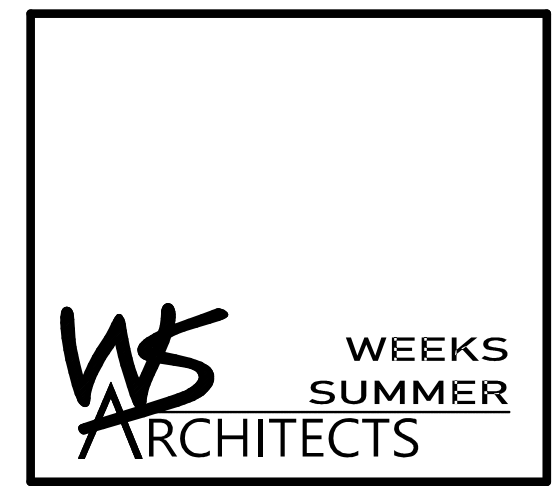
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WVS: 15RE.13.3  
SCO ID# 21-24079-01A

PROJECT TITLE  
**BRUNSWICK CTY VISITOR'S CENTER**  
394 WHITEVILLE ROAD NW  
SHALLOTE, NORTH CAROLINA

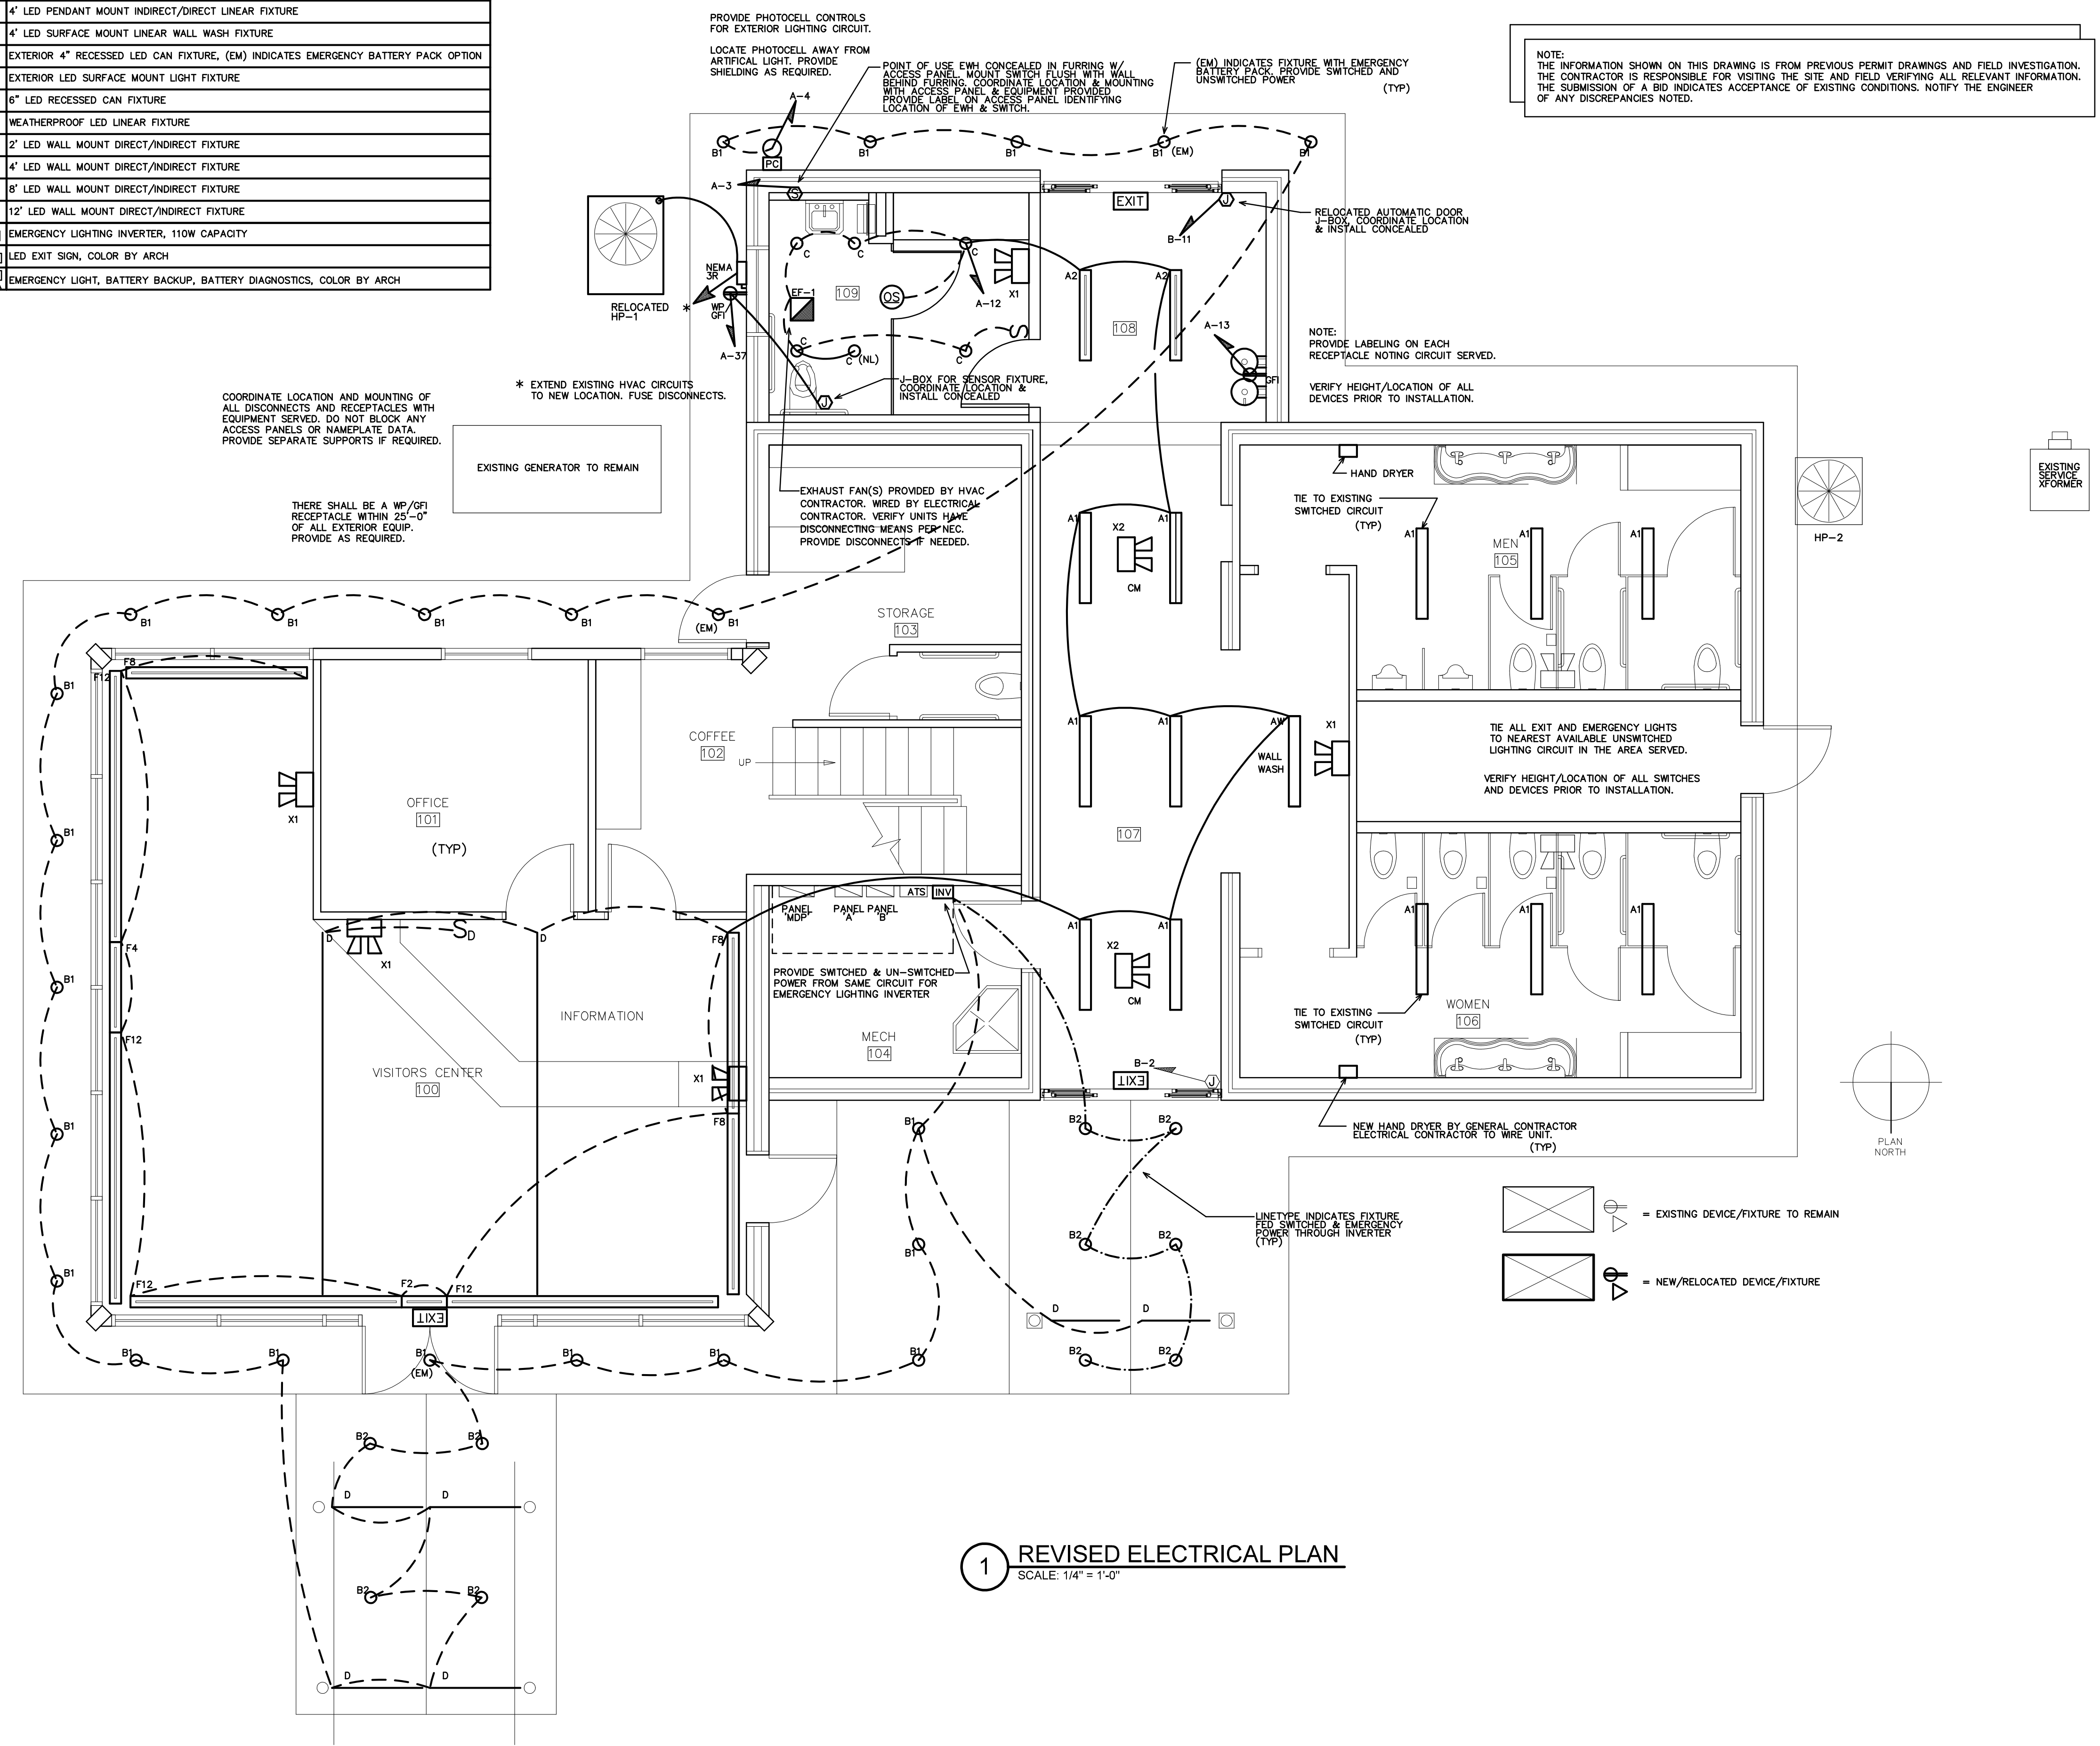PROJECT NO.  
2104A  
DRAWING TITLE  
NEW ELEC PLAN



PLOT DATE 6/16/23

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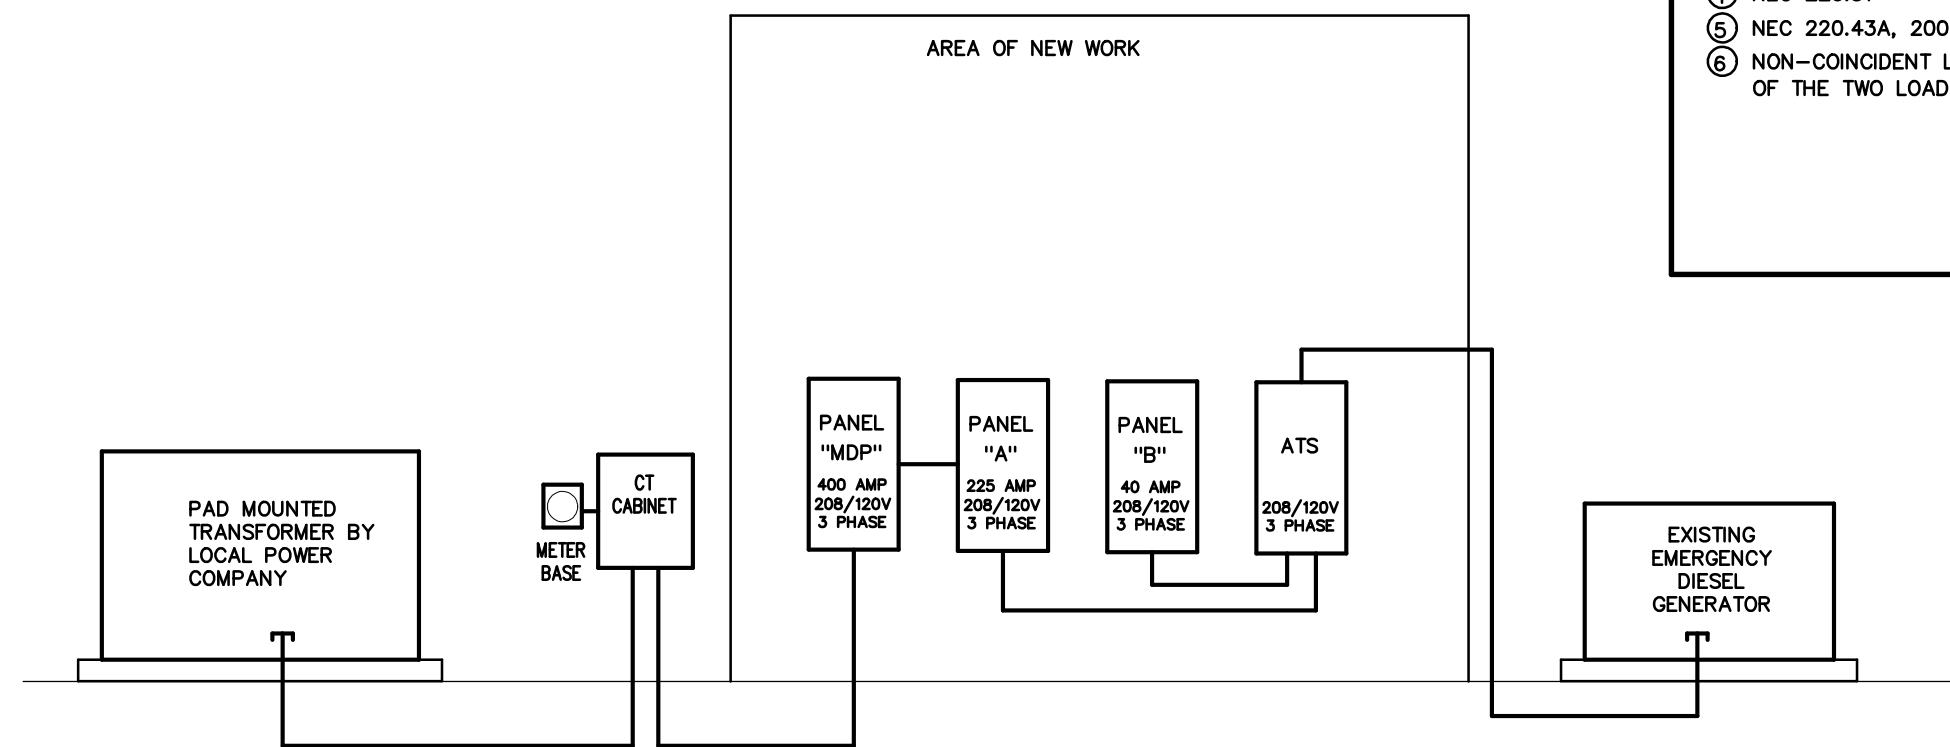
Table with columns for LOAD SERVICE, CKT BRKR, WATTS PER PHASE, NEUTRAL, and M.L.O. MAIN CIRCUIT BREAKER. Includes sub-totals and total connected load.

Table for REVISED PANEL - 'MDP' with columns for LOAD SERVICE, CKT BRKR, WATTS PER PHASE, NEUTRAL, and M.L.O. MAIN CIRCUIT BREAKER. Includes sub-totals and total connected load.

Table with columns for NEC ALLOWABLE DEMAND FACTORS and DIVERSIFIED LOAD SUMMARY. Includes demand factors per NEC 220 and a detailed load summary table.

VERIFY AVAILABLE FAULT CURRENT AT SERVICE LOCATION WITH LOCAL POWER COMPANY. PROVIDE INFORMATION TO ENGINEER TO CALCULATE MINIMUM PANEL AIC RATING. EC SHALL PROVIDE LABELING INDICATING FAULT CURRENT AT SERVICE ENTRY AND ON ALL PANELS PRIOR TO ENERGIZING.

NOTE: THE ELECTRICAL SERVICE IS EXISTING AND SHOWN FOR REFERENCE ONLY. NO NEW WORK IS REQUIRED.



EXISTING SERVICE RISER SCALE: NOT TO SCALE

Table for EXISTING PANEL - 'A' with columns for LOAD SERVICE, CKT BRKR, WATTS PER PHASE, NEUTRAL, and M.L.O. MAIN CIRCUIT BREAKER. Includes sub-totals and total connected load.

Table for REVISED PANEL - 'A' with columns for LOAD SERVICE, CKT BRKR, WATTS PER PHASE, NEUTRAL, and M.L.O. MAIN CIRCUIT BREAKER. Includes sub-totals and total connected load.

Table with columns for NEC ALLOWABLE DEMAND FACTORS and DIVERSIFIED LOAD SUMMARY. Includes demand factors per NEC 220 and a detailed load summary table.

LIGHTING SCHEDULE \*

Table with columns for MARK, MANUFACTURER, CATALOG NO., VOLT, LAMPS, BALLAST, W/FIXTURE, REMARKS, ALTERNATE 1, and ALTERNATE 2. Lists various lighting fixtures and their specifications.

\* OR APPROVED EQUAL. PROVIDE CUT SHEETS FOR OWNER APPROVAL PRIOR TO ORDERING FIXTURES. CATALOG NUMBERS ARE FOR REFERENCE ONLY. ACTUAL NUMBERS MAY VARY. 'EB' DENOTES ELECTRONIC BALLAST. 'EDB' DENOTES ELECTRONIC DIMMING BALLAST. \*\* 'F' FIXTURES MAY BE ORDERED IN CONTINUOUS LENGTHS IF AVAILABLE FROM MANUFACTURER. THE EMERGENCY LIGHTS AND EXIT SIGNS MUST HAVE INTEGRAL BATTERIES, CHARGERS AND TEST SWITCHES.


Table for EXISTING PANEL - 'B' with columns for LOAD SERVICE, CKT BRKR, WATTS PER PHASE, NEUTRAL, and M.L.O. MAIN CIRCUIT BREAKER. Includes sub-totals and total connected load.

Table for REVISED PANEL - 'B' with columns for LOAD SERVICE, CKT BRKR, WATTS PER PHASE, NEUTRAL, and M.L.O. MAIN CIRCUIT BREAKER. Includes sub-totals and total connected load.

EQUIPMENT WIRING SCHEDULE

Table with columns for EQUIPMENT, MCA, MOC, VOLTS, PH, and WIRE SIZE. Lists equipment like EWH with its electrical requirements.

NOTE: THE ELECTRICAL CONTRACTOR SHALL VERIFY ALL EQUIPMENT ELECTRICAL REQUIREMENTS PRIOR TO ROUGH-IN AND RELEASING GEAR. ADJUST BREAKER, WIRE SIZES, ETC. AS REQUIRED.

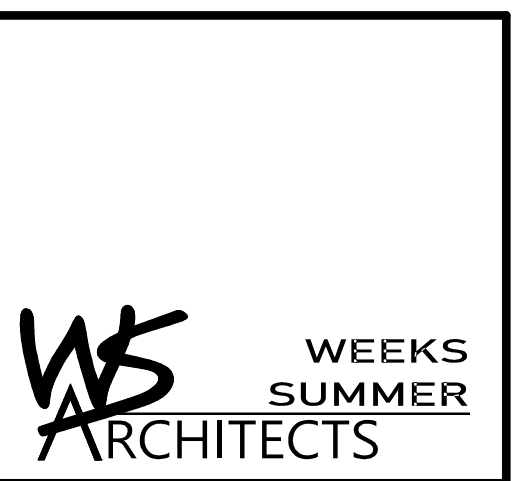

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BID SET 4.28.22

WVS: 15RE.13.3

SCO ID# 21-24079-01A

PROJECT TITLE BRUNSWICK CITY VISITOR'S CENTER 394 WHITEVILLE ROAD NW SHALLOTE, NORTH CAROLINA

PROJECT NO. 2104A

DRAWING TITLE ELEC. PANELS & RISER

PLOT DATE 6/16/23

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